

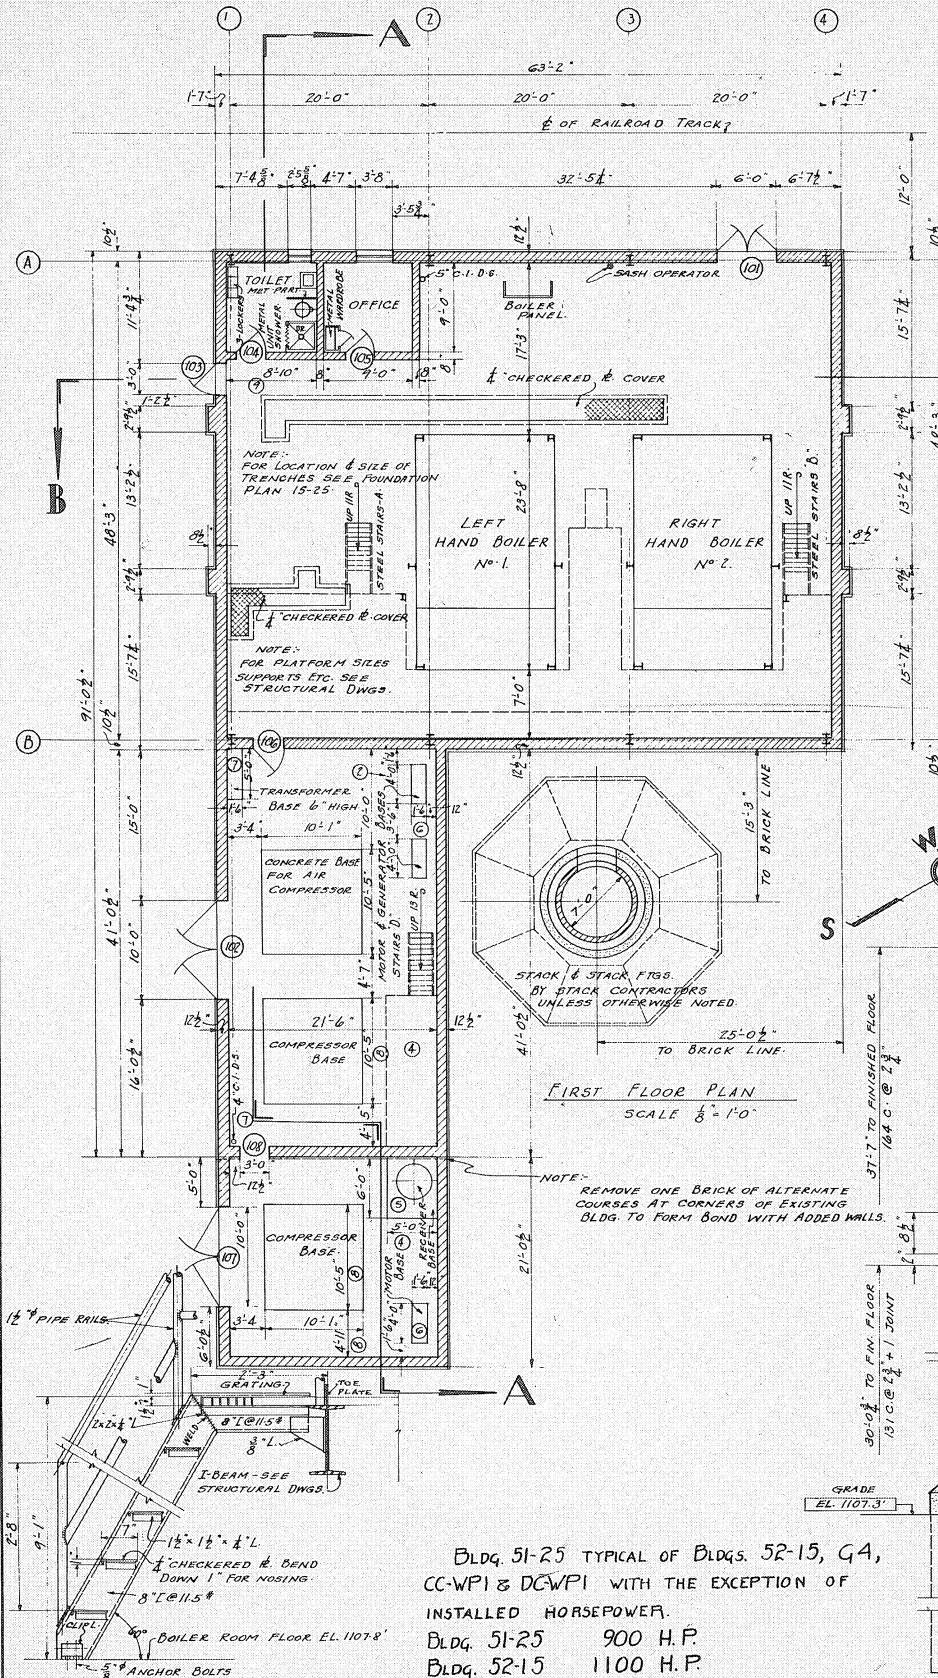
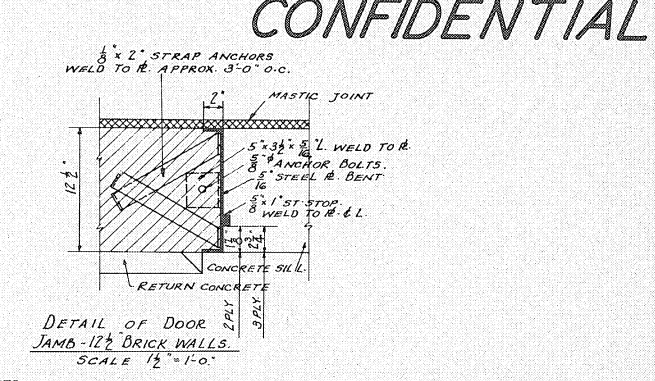
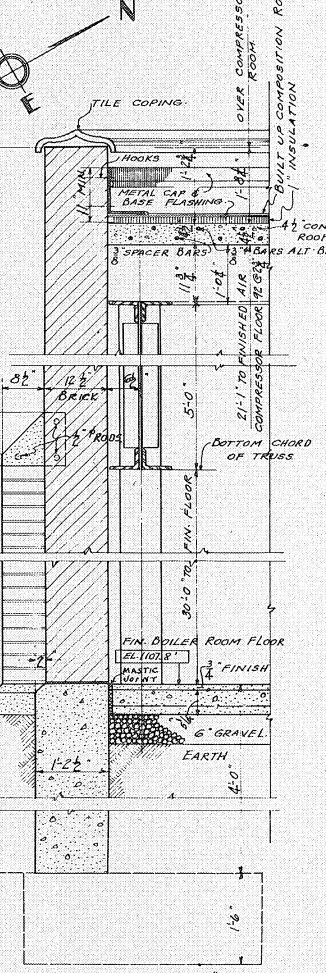


DOOR NUMBER	TYPE	MASONRY OPENING	WALL THICKNESS	WIDE	HIGH	THICK	MATERIAL	FRAME & TRIM	THRES-HOLD	TRANSOM	LINTEL	REMARKS
101 (PRIK)	D	12" BRICK	2-11"	7'-0"	7'-0"	2 PLY	METAL CLAD	BENT R	NONE	NONE	2-4x4	DOOR FRAME ON HARD
103, 106	M	12" BRICK	2-11"	7'-0"	7'-0"	2 PLY	METAL CLAD	BENT R	NONE	NONE	3-3x3x4	DOOR FRAME ON HARD
104, 105	M	8" BRICK	2-11"	7'-0"	7'-0"	2 PLY	METAL CLAD	L FRAME	NONE	NONE	3-3x3x4	DOOR FRAME ON HARD
102 (PRIK) 107 (PRIK)	M	12" BRICK	2-11"	7'-0"	7'-0"	3 PLY	METAL CLAD	BENT R	NONE	NONE	3-3x3x4	DOOR FRAME ON HARD
108		3'-0" T	12" BRICK	10'-0"	10'-0"							

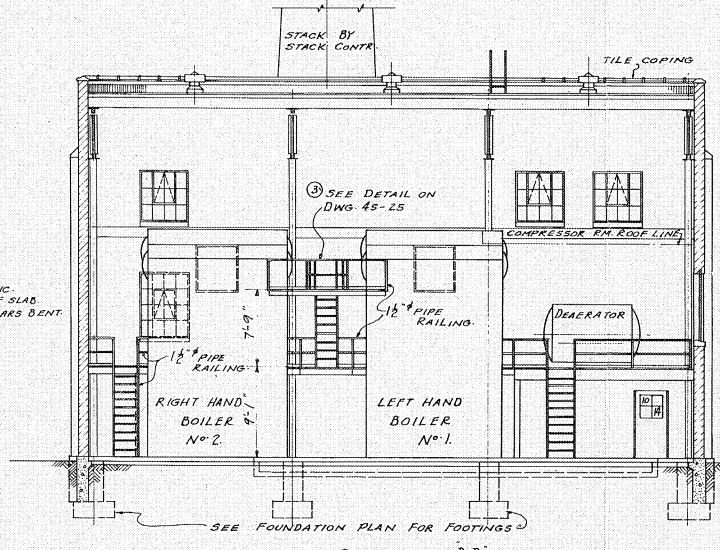

LINTEL SCHEDULE

L-1	3-4 x 3 1/2 x 9/16"	JLL
L-2	3-3 1/2 x 3 1/2 x 9/16"	JLL
L-3	2-6 x 4 x 3/8"	JLL
L-4	1-10" L @ 15.3" x 1/2 x 9/16"	JLL

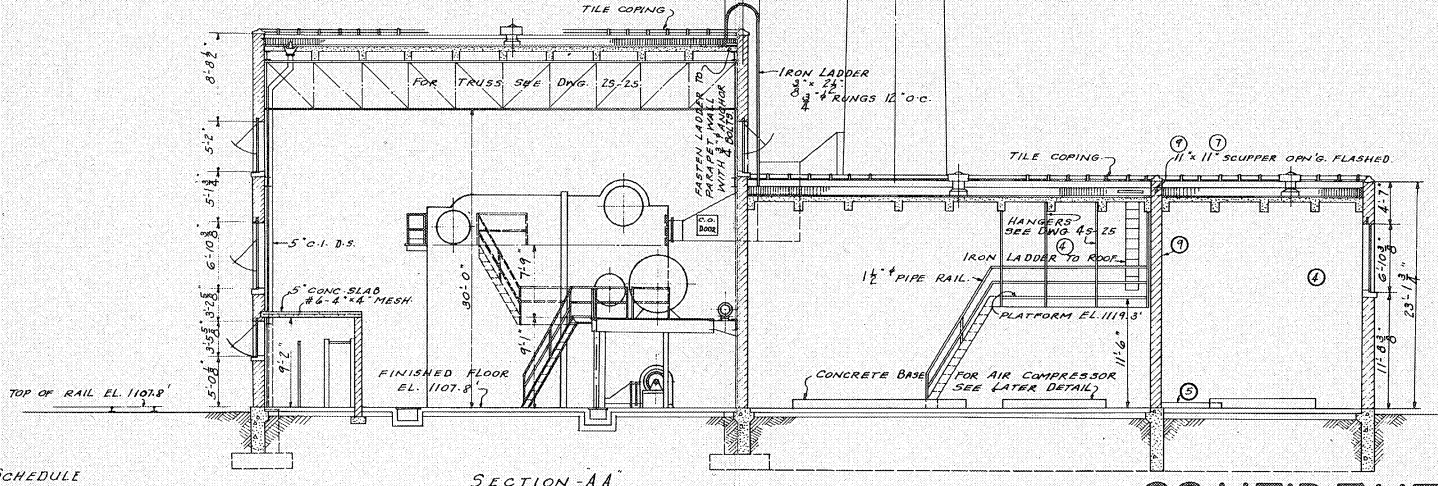


NOTE: ALL WINDOWS TO HAVE GUARD SCREENS ON INSIDE OF FULL MASONRY OPENING - SEE DWG. 108-B FOR PRECAST CONG. SILLS - CAST FOR 12" WALL - ALL PIPE RAILINGS TO HAVE WELDED JOINTS - ALL WINDOWS EXCEPT TOILET SHALL BE GLAZED WITH OBSCURE GLASS EXCEPT BOTTOM ROW OF LIGHTS WHERE D.S.B. GLASS SHALL BE USED - TOILET ROOM WINDOWS WITH OBSCURE GLASS THRU-OUT. DOORS WITH 1/2" CLEAR WIRE GLASS EXCEPT TOILET ROOM DOOR TO HAVE OBSCURE GLASS.

IMPORTANT NOTE: FOR AIR INTAKES - TRENCHES & AIR COMPRESSOR PLATFORM SEE LATER DETAILS.

INDEX OF DRAWINGS

DWG No.	TITLE	APPLIES TO BLDG.
IA-25	FLOOR PLAN - SECTIONS - DETAILS	51-25
2A-25	UPPER PLATFORMS - ELEVATIONS	"
15-25	FOUNDATION PLAN & SECTIONS	"
25-25	PLAN TRUSS & DETAILS	"
35-25	ANCHOR BOLT PLAN	"
45-25	PLATFORM FRAMING	"
EI-25	POWER & LIGHTING LAYOUT	"
108-B	DOORS - SASH - DETAILS	"

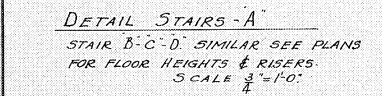

BLDG. 51-25 TYPICAL OF BLDGS. 52-15, G4, CC-WPI & DC-WPI WITH THE EXCEPTION OF INSTALLED HORSEPOWER.

BLDG. 51-25	900 H.P.
BLDG. 52-15	1100 H.P.
BLDG. G4	900 H.P.
BLDG. CC-WPI	900 H.P.
BLDG. DC-WPI	900 H.P.

APPROVED 7/2/41
E.A. Haine
ATL: POWDER COMPANY

WILBUR WATSON AND ASSOCIATES
ARCHITECTS AND ENGINEERS
Cleveland, Ohio
Cleveland, Ohio

CONSTRUCTION DIVISION
OFFICE OF THE QUARTERMASTER GENERAL
RAVENNA ORDNANCE PLANT
PERCUSSION ELEMENT LINE
BOILER HOUSE
FLOOR PLAN - SECTIONS - DETAILS

SCALE: 63'-2" X 91'-0" 1/2"

REVISIONS	DATE	BY
1	7-6-41	E.A. Haine
2	7-6-41	E.A. Haine
3	7-6-41	E.A. Haine
4	7-6-41	E.A. Haine
5	7-6-41	E.A. Haine
6	7-6-41	E.A. Haine
7	7-6-41	E.A. Haine
8	7-6-41	E.A. Haine

APPROVED BY DIRECTION: E.A. HAINE /s/

DATE: 7-6-41

PROJECT: W.A.L. 7-6-41

TRACED BY: TRACING CREW

DATE: 3/23/42

SCALE: 3/4" = 1'-0"

TYPE: 25

DATE: 7-6-41

NO. OF COPIES: 6934

PROJECT NO.: 610.201

ASST. CONSTRUCTING Q-MASTER